

1/4" = 1'-0"

GENERAL NOTES:

1. DO NOT SCALE DRAWINGS. 2. ALL DRAWING UNITS ARE IMPERIAL UNLESS OTHERWISE NOTED.

3. ALL CONSTRUCTION SHALL CONFORM TO THE LATEST EDITION OF THE O.B.C. AND BE IN ACCORDENCE WITH PROPER CONSTRUCTION PRACTICES. 4. WNDOW & DOOR SIZES ON PLANS ARE NOMINAL. FOR R.S.O., CONSULT WITH MANUFACTURER OF CHOICE.

5. FOR ENGINEERED ROOF TRUSSES & FLOOR SYSTEMS CONSULT W/MANUFACTURER OF CHOICE. MANUFACTURER TO SUPPLY PROPER SIZE, SPACING & BRACING DETAIL AS PER DRAWING.

6. SLOPE FINISHED GRADE TO DRAIN SURFACE WATER AWAY FROM BUILDING.

7. PROVIDE 1 SQ./FT OF VENTILATION FOR EVERY 300 SQ./FT. OF INSULATED ATTIC SPACE, WITH 50% AT EAVES AND 50% NEAR THE RIDGE. 8. ALL PERMITS ARE THE RESPONSIBILITY OF THE CONTRACTOR AND OR OWNER.

9. CONTRACTORS SHALL CHECK AND VERIFY ALL DRAWINGS. CONTRACTORS SHALL NOTIFY ARMSTRONG CONTRACTING OF ANY DISCREPANCIES AND OMISSIONS BEFORE PROCEDING WITH WORK.

10. ALL DIMENSIONAL LUMBER TO BE OF SPF.#1 OR #2

11. EXTEND ALL WASHROOM & KITCHEN EXHAUSTS UP THROUGH NEW ATTIC SPACE. 12. PROVIDE ATTIC ACCESS TO ALL ROOF SPACES - MIN. 19.75"X28"

FOOTINGS:

1. ALL FOOTINGS SHALL REST ON UNDISTURBED SOIL MIN. 4'-0" BELOW GRADE.

2. WHEN STEP FOOTINGS ARE USED, THE VERTICAL RISE BETWEEN HORIZONTAL PORTIONS SHALL NOT EXCEED 600mm (23 5/8"), FOR FIRM SOILS AND 400mm (15-3/4") FOR SAND OR GRAVEL, AND THE HORIZONTAL DISTANCE BETWEEN RISES SHALL BE NOT LESS THAN 600mm (23-5/8").

\triangleright	Date:	Revisions:
1	Sept 21/25	Garage door size, add gable window

Do not scale drawings.
All dimensions to be verified on site. Any descrepancies to be reported to the Drawings are not to be used for construction, unless approved by building

omcais.

Drawings are the property of
Armstrong Contracting and should not be
reproduced without written permission from
the draftsperson.

The undersigned has reviewed and takes responsibility for this design, and has the qualifications and meets the requirements set out in the Ontario Building Code to be a designer.

QUALIFICATION INFORMATION Required unless design is exempt under 3.2.5 of Division C, of the building code.



REGISTRATION INFORMATION Design is exempt under 3.2.4 of Division C, of the building

Armstrong Contracting	32826
FIRM NAME	BCIN

ARMSTRONG CONTRACTING

DESIGN BUILD RENOVATE

Christopher Armstrong 936447 Mulmur, Ont. L9V 0L5 H - (705)435-4256 C - (705)434-8282

Project Title:

New Garage Plans For Kyle Griffiths

Reviewed & Accepted By Owner.


Drawing Title:

Footing/Slab Plan

CA CA Checked by: Date: Drawing No.:

Aug 16/25 1/4" = 1'-0"

A-1

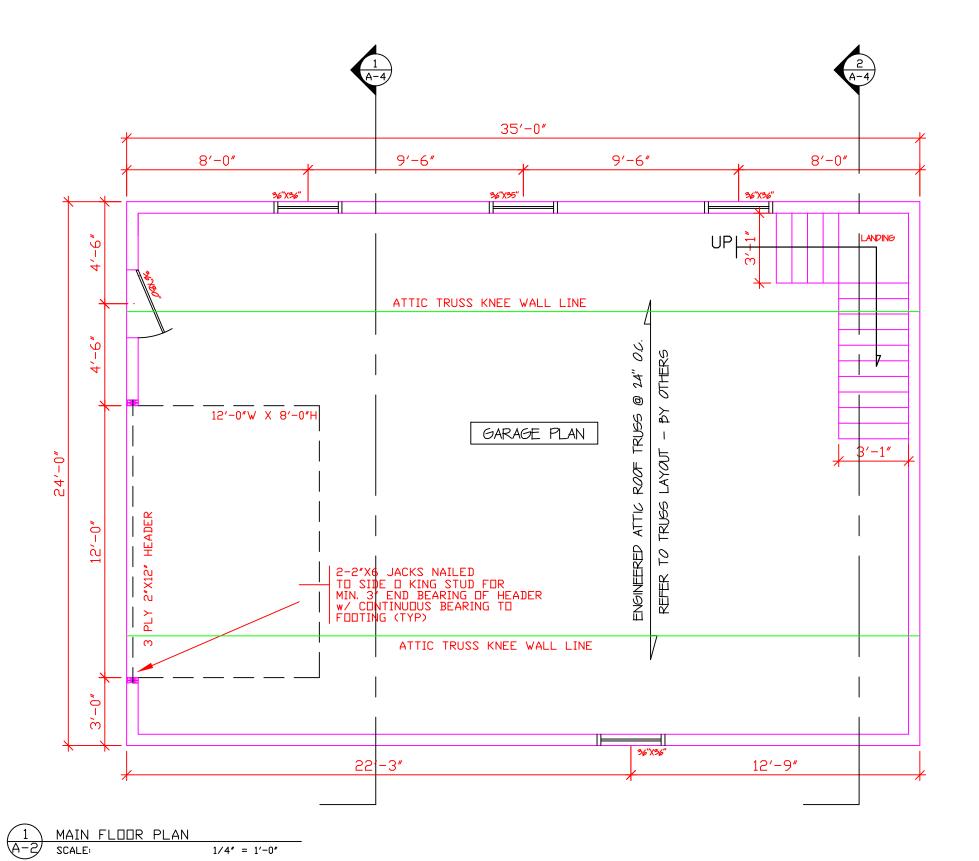

NOTE:

ALL HEIGHTS TO BE CONFIRMED

ON SITE BY CONTRACTOR BEFORE
BUILDING STARTS. ON-SITE

ADJUSTMENTS MAY HAVE TO BE MADE.

NOTE:

UNLESS NOTED, ALL EXTERIOR
DOOR & WINDOW HEADERS TO BE
3 PLY 2"x10"

\triangleright	Date:	Revisions:
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Project Title:

New Garage Plans For Kyle Griffiths

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Drawing Title:

Main Floor Plan

Drawn by: CA


Checked by: CA

Date: Drawing No.:

Scale: 1/4" = 1'-0"

Aug 16/25

A-2

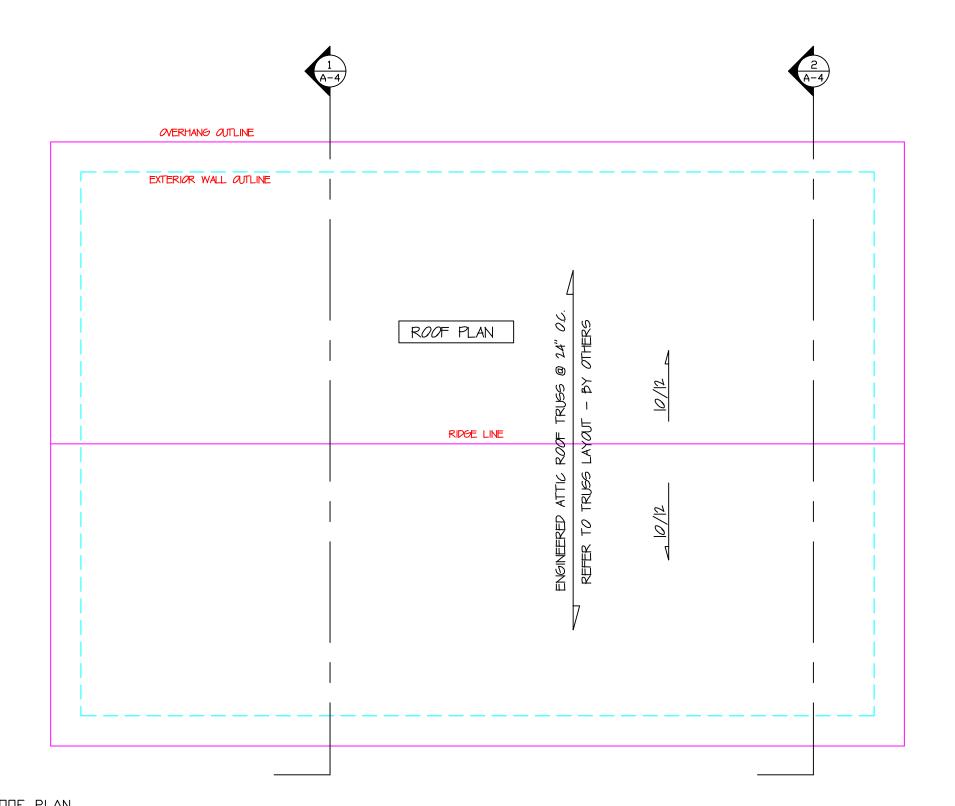

SCALE:

1/4" = 1'-0"

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	1	Sept 21/25	Garage door size, add gable window
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Armstrong Contracting 32826

FIRM NAME BCIN

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ARMSTRONG CONTRACTING

DESIGN BUILD RENOVATE

Christopher Armstrong 936447 Mulmur, Ont. L9V 0L5 H - (705)435-4256 C - (705)434-8282

Project Title:

New Garage Plans For Kyle Griffiths

Reviewed & Accepted By Owner.

Drawing Title:


Roof Plan

Drawn by: CA
Checked by: CA


Date: Aug 16/25 Scale: 1/4" = 1'-0"


A-3


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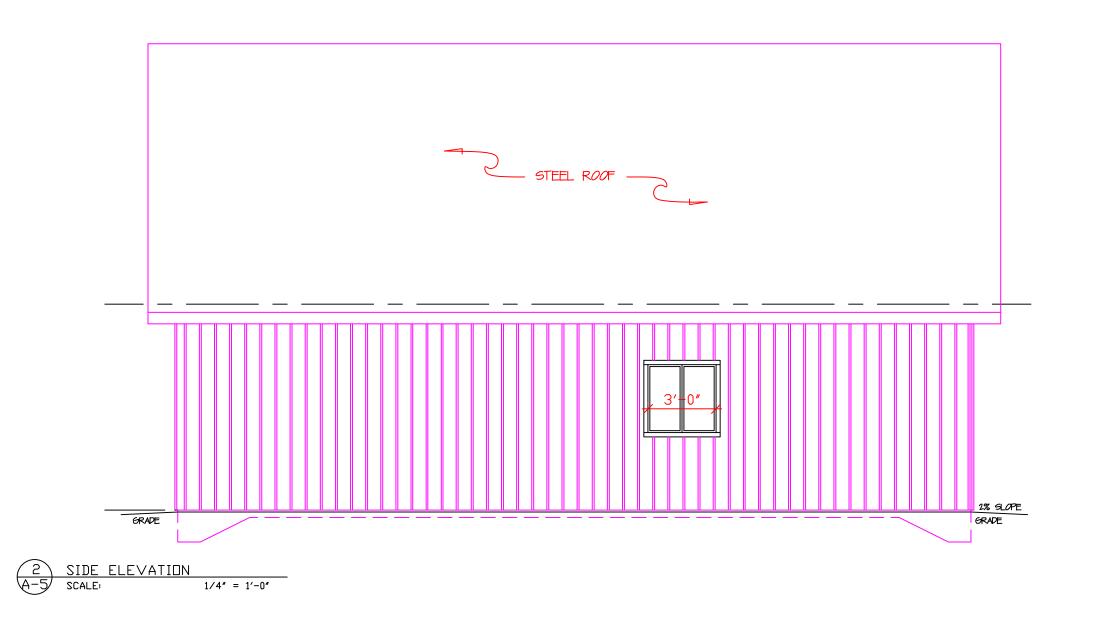


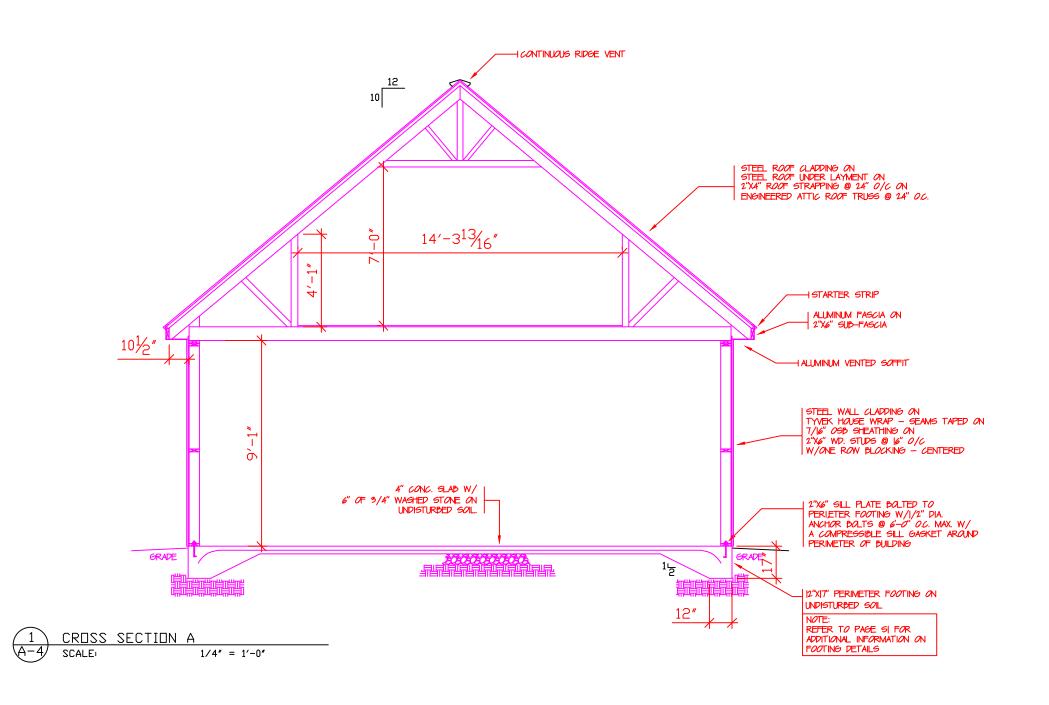
2 A-4




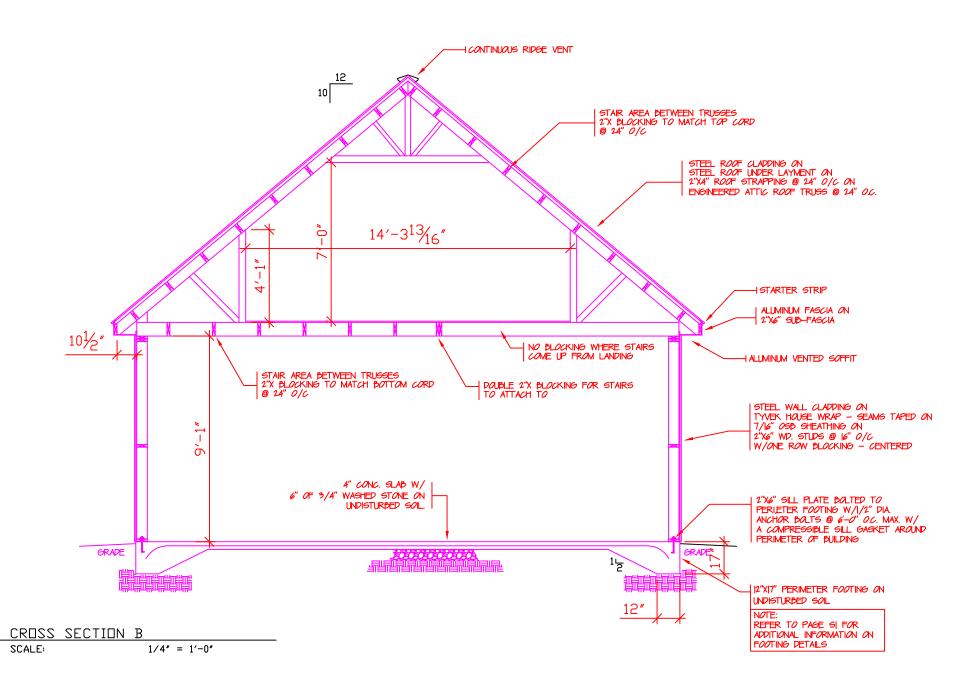


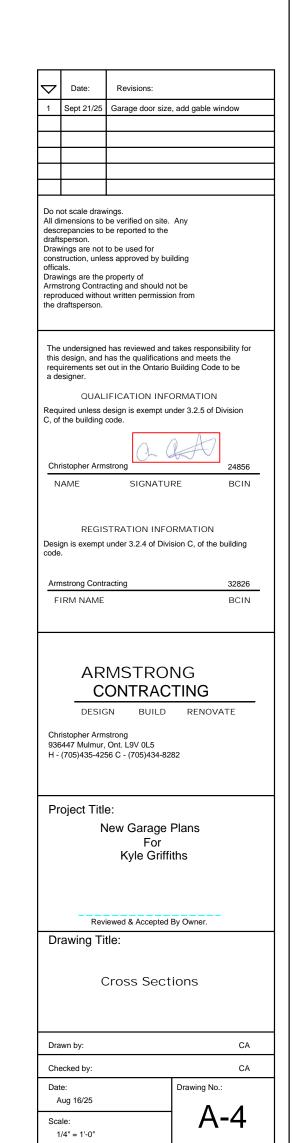

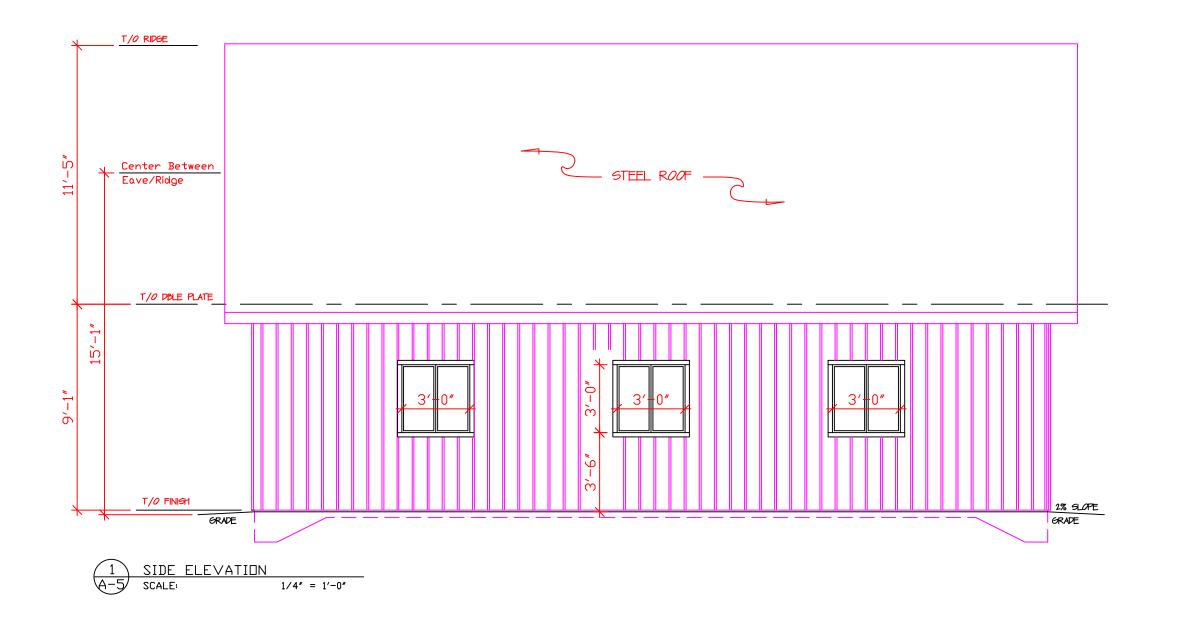


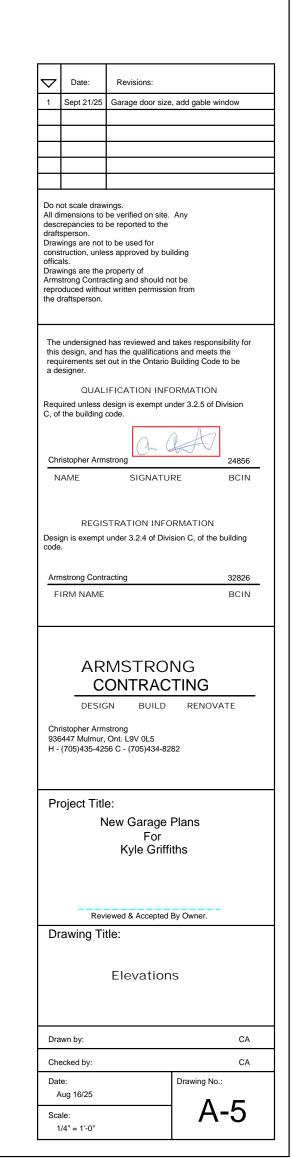

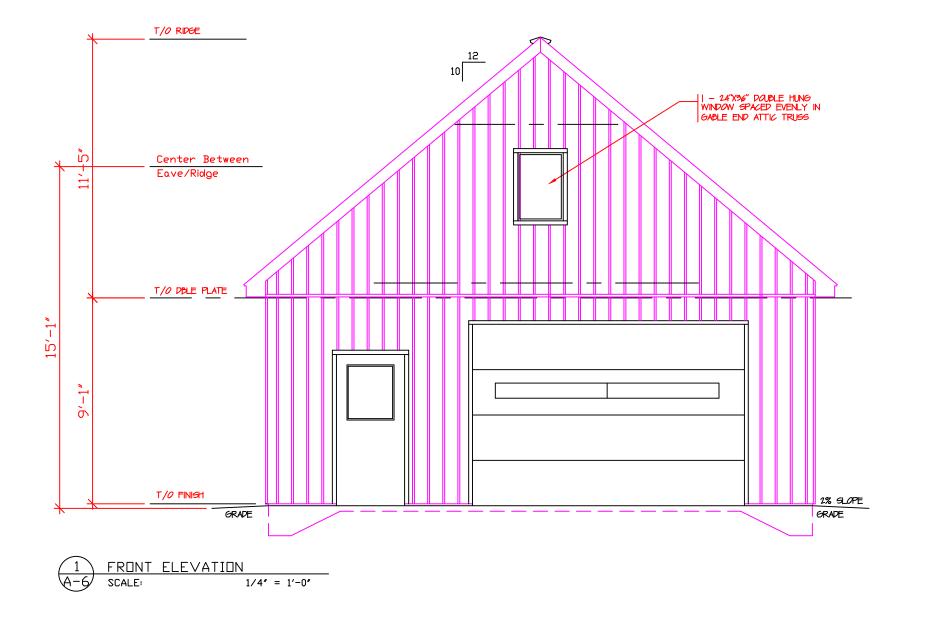

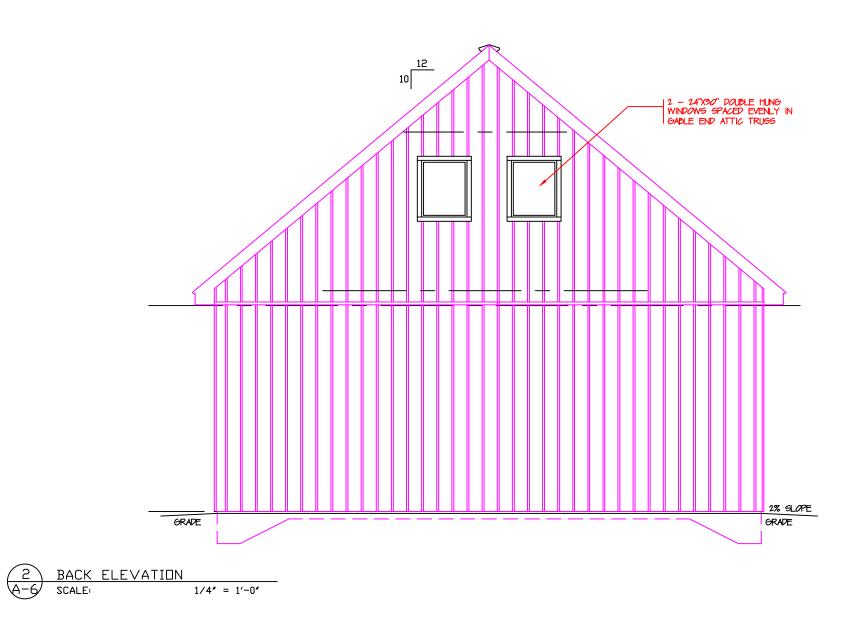

$\overline{\ }$	Date:	Revisions:			
1	Sept 21/25	Garage door size, add gable window			
All di desc draft Drav cons offica Drav Arms	Do not scale drawings. All dimensions to be verified on site. Any descrepancies to be reported to the draftsperson. Drawings are not to be used for construction, unless approved by building officals. Drawings are the property of Armstrong Contracting and should not be reproduced without written permission from the draftsperson.				
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Chi	istopher Arm	strong	A	24856	
	gn is exempt	STRATION INFO under 3.2.4 of Divi		uilding	
code					
_	nstrong Contr	racting		32826 BCIN	
ARMSTRONG CONTRACTING DESIGN BUILD RENOVATE Christopher Armstrong 936447 Mulmur, Ont. L9V 0L5 H - (705)435-4256 C - (705)434-8282					
Pr	Project Title: New Garage Plans For Kyle Griffiths				
	Reviewed & Accepted By Owner.				
Dr	Drawing Title: Elevations				
Dra	wn by:			CA	
	ecked by:	1	December 11	CA	
Dat A Sca	ug 16/25		Drawing No.:	-6	
1	/4" = 1'-0"				

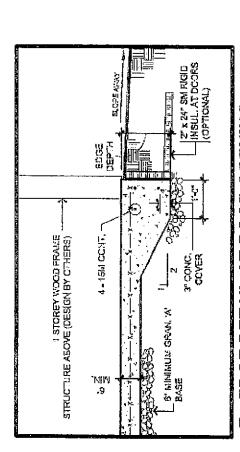

OPENING SCALE: 12" = 1:0

EDGE THICKNESS

GENERAL NOTES:
1. THIS DESIGN HAS BEEN COMPLETED TO THE 2012 ONTARIO SUILDING CODE.
2. CONTACT TACOMA ENGINEERS FOR CONSTRUCTION REVIEWS AS REQUIRED BY THE LOCAL MUNICIPALITY.
3. THIS FCUNDATION DESIGN SHALL NOT BE USED IN GEOGRAPHIC AREAS SUBJECT TO TERMITE INFESTATION.

Ģ **.** ą,

MAX, 20-0 MAX, 24'-0' MAX 28-0

LARCEST DIMENSION

TABLE 1

ê Ļ

E-X, 33.0 MAX 35.0 MAX, 40'-0"

.8

SITE & SOLLS:

1. PREFARE THE AREA FOR PROPOSED STRUCTURE BY REMOVING ALL TOPSOIL AND CREANIC NATERIAL FROM THE AREA OF THE BUILDING.

2. SLOPE FINAL GRADE AWAY FROM THE BUILDING.

3. BEAR BLAB ON GRANULAR FILL (8" MINIMUM.) TO 98% STANDARD PROCTOR DENSITY OR 34" CRUSHED STONE ON SOUND ORIGINAL (NATIVE) SLIBGRADE.

4. SUBGRADE SHALL BE SUITABLE FOR 75 KP2 (1500 ps.) SAYE BEARING.

NOTE: FOR FOUNDATIONS WITH GREATER THAN 40-0" DIMENSIONS, FOUNDATION DESIGN MUST BE COMPLETED BY A PROFESSIONAL ENGINEER

CONCRETE:

1. CÓNCRETE WORK SHALL CONFORM TO CANUSA-A23.12.3 FOR MATERIALS AND WORKGANG-IP.

OLASS OF CONCRETE STRENGTH WICKATIO AIR ENTRAINMENT

C2 32 MPa 0.45

6.45

2. ALL CONCRETE SHALL BE KEFT MOIST DURING THE FIRST THREE DAYS OF CURING, DO NOT AJO WATER TO CONCRETE ON SITE.
3. ALL REBAR SHALL BE DEFORVED 6ARS WITH A MINIMUM YIELD STRENGTH OF 400 MPa. ALL LAF LENGTHS AS FOLLOWS:

ALL LAF LENGTHS AS FOLLOWS:

B. 10M BARS 45cmm (147)

B. 16M BARS 45cmm (147)

B. 16M BARS 45cmm (147)

B. PROVIDE A MINIMUM 91 LAF FCR VIELTED WHEE WESH, SANDH (50M:20" BEST DOWNELS FCR CORNER).

COWELS (FOLR DOWNELS FCR CORNER).

INSULATION: 1. ALL REULATION SHALL BE EXTRUDED POLYSTYRENE FOAN (APS) TYPE IV, Y, YI OR VII WITH A MINIMUM NOMBARL REVALUE OF RS / INCH.

THIS CAPING SELVE FOUNDATION DESIGN IS FOR A 1 STOREY WOOD STUD FRAVED STRUCTURE WITH NO VASCARY OR OTHER CRACK SUSCEPTIBLE FINISHES.

OR OTHER CRACK SUSCEPTIBLE FINISHES.

DETERMINE THE LARGER SULUNG DIMENSION, LENGTH OR WIDTH AND SELECT EDGE DEPTHERM TABLE 1.

NOTE: SLAB DESIGN IS NOT AFFECTED BY SPAN OF ROOM TO BOTH THE LENGTH AND WIDTH.

TO NOULDE ATHET TRUSSES ADD. THE WIDTH OF THE ROOM TO BOTH THE LENGTH AND WIDTH.

TO ADD UP TO 49" OF MASCARY VENEET AND THE PERINETER, INCREASE EDGE DEPTHEY Z. INSTALL VERTICAL CONTROL JOINTS IN VENEER AT MAX, 340" O.C.

BURLDINGS THAT DO NOT WEET THE ASOVE CRITERIA. SHALL NOT USE THIS DETAIL.

ZALOY X 30°C? WITH ATTIC TRUSS (12°C) WIDE ROCK IN TRUSS SPACE)

Particular CONFIGURE

EFFECTIVE SLAB DIMENSIONS (24-07 + 12-07) = 33-07 AND (50-0* + 12-0") = 62-0

FROW TABLE 1, FOR 38-0" —> SELECT 17" EDGE THICKMESS FOR BRICK VENEER ADD 2" TO EDGE THICKNESS

18'-0" x 38'-0" WITH 4'-0" BRICK VENEER,


EXAMPLE 1:

.. INSTALL SLAB WITHA 19" EDGE THICKNESS

EFFECTIVE SLAB DIMENSION IS OFF THE CHART. USG OF THIS PLAN IS NOT PERMITTED.



Compared Com

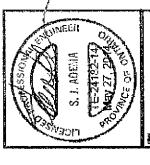




FLOATING SLAB TYPICAL

FOUNDATION FLAN

& HOTES

\$100 April

(\$T) 1514 1514 16-2412.0

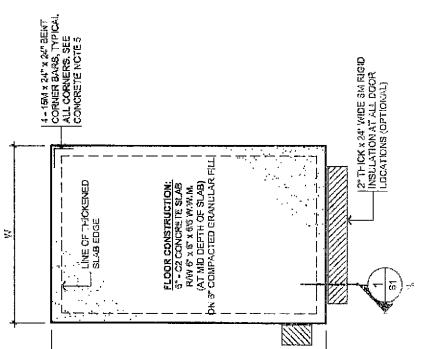

FOUNDATION PLAN